SAMPLE DRAWINGS **CONSTRUCTION CODE AUTHORITY - SK**

BuildTECH

Inc.

CODE AUTHORITYOf Saskatchewan

CONSTRUCTION

LIST OF DRAWINGS

ARCHITECTURAL:

A-1.0 TITLE PAGE

A-2.0 GENERAL NOTES
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A-2.1 SITE PLAN

A-3.0 BASEMENT FLOOR PLAN - EXISTING
A-3.1 BASEMENT FLOOR PLAN - REVISED

A-4.1 MAIN FLOOR PLAN - REVISED

A-4.0 MAIN FLOOR PLAN - EXISTING

A-5.1 MAIN FLOOK PLAN - REVISE A-5.0 ROOF PLAN

A-6.0 MAIN FLOOR JOIST LAYOUT

A-7.0 TYP. CONSTRUCTION ASSEMBLIES

A-7.1 ENERGY EFFICIENCY REVIEW SECTION 9.38. NBC 2015
A-7.2 ENERGY EFFICIENCY REVIEW


A-7.2 ENERGY EFFICIENCY REVIEW CALCULATIONS

A-8.0 BUILDING SECTION

A-8.1 BUILDING SECTION

A-8.2 BUILDING SECTION

A-9.0 EXTERIOR ELEVATIONS
A-9.1 EXTERIOR ELEVATIONS

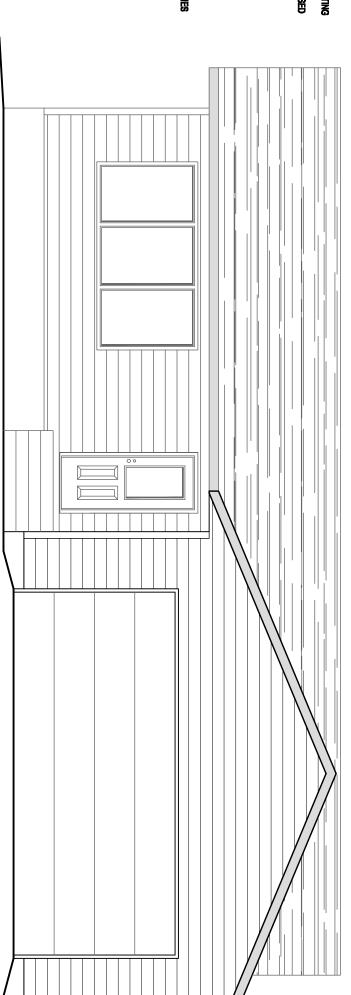

SAMPLE SET ONLY

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DRAWING NAME:

TITLE PAGE

DATE:

November 13, 2020

PROJECT #:

2020-96

A-1.0

DRAWN:

BUILDING AREA

MAIN FLOOR EXISTING: 1025 SQ. FT.
MAIN FLOOR ADDITION: 198 SQ. FT.
GARAGE ADDITION: 579 SQ. FT.
3 SEASON ROOM ADDITION: 168 SQ.

Ξ

NOTE: ALL AREAS INCLUDE EXTERIOR WALLS

¥	WINDOW SCHEDULE:		
	LOCATION:	SIZE:	QTY:
Ð	DINING ROOM SEE NOTE 3	60"x60"	_
⊚	KITCHEN	72"x40"	_
(©)	3 SEASON'S ROOM SEE NOTE 4	30"x72"	6
Θ	MASTER BEDROOM SEE NOTE 3	48"x48"	1

- WINDOW NOTES:

 1. CONTRACTOR TO CONFIRM WINDOW SIZES AND ROUGH OPENINGS WITH WINDOW SUPPLIER

 2. NEW WINDOWS TO CONFORM TO SECTION 9.36. OF THE NATIONAL BUILDING CODE OF

 CANADA 2015. SEE PAGE A-7.1.

 3. CONTRACTOR TO CONFIRM EXISTING WALL THICKNEES PRIOR TO ORDERING NEW WINDOWS.

 4. WINDOWS IN 3 SEASON ROOM (UNHEATED) NEED NOT CONFORM TO SECTION 9.36. OF THE

 NATIONAL BUILDING CODE OF CANADA 2015 AS PER A-9.36.1.3.(5)

GENERAL NOTES:

CONTRACTOR TO CONFORM TO PART 9 OF NATIONAL BUILDING CODE OF CANADA

DO NOT SCALE DRAWINGS. ALL DIMENSIONS TO BE CONFIRMED BY CONTRACTOR

ALL DIMENSIONS ARE FROM OUTSIDE OF EXTERIOR SHEATHING TO CENTER LINE OF WALLS OR TO CENTER OF WINDOW OPENINGS

CONTRACTOR TO REVIEW AND CONFIRM WINDOW SIZES

ALL DOORS TO BE 6'-8" UNLESS NOTED OTHERWISE

ALL LINTELS $2-2\text{"}\times10\text{"}$ UNLESS NOTED OTHERWISE

ALL DIMENSION LUMBER MEMBERS (JOISTS, B.U. BEAMS, LINTELS ETC.) ARE SIZED FROM "SPAN BOOK". THE NATIONAL BUILDING CODE OF CANADA 2015 REFERENCES THE "SPAN BOOK" IN APPENDIX A-9.23.4.2.

CONTRACTOR & OWNER TO DETERMINE PLACEMENT OF RESIDENCE ON PROPERTY; MUST CONFORM TO LOCAL &

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STEP FOOTINGS SHALL HAVE MAXIMUM RISE OF 600mm A MINIMUM RUN OF 600mm (9.15.3.9. NBC 2015)

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CONTRACTOR TO VERIFY SETBACKS TO PROPERTY LINES ON SITE AND CONFORM TO MUNICIPAL BYLAWS

DOUBLE JOISTS AROUND ALL FLOOR OPENINGS AND UNDER PARALLEL PARTITIONS

CONTRACTOR TO INSURE POSITIVE DRAINAGE AWAY FROM RESIDENCE

THE DRAWINGS HEREIN ARE A GUIDE ONLY, CONTRACTOR TO ENSURE DRAWINGS MET LOCAL BUILDING CODES AND PRACTICES, VETTIER DRAFTING AND HOME DESIGN NOT RESPONSIBLE FOR ANY CHAWGES DONE AFTER SUBMISSION OF DRAWINGS TO THE OWNER

ELECTRICAL LAYOUT AND DESIGN TO BE DONE BY OWNER AND ELECTRICAL CONTRACTOR

PRESERVED WOOD FOUNDATIONS SHALL CONFORM TO CAN/CSA-S406 "CONSTRUCTION OF PRESERVED WOOD FOUNDATIONS"

ROUGH IN PIPE FOR RADON GAS AS PER NBC 2015 (9.13.4.3)INSULATED CONCRETE FORMS SHALL BE REINFORCED WITH REBAR CONFORMING TO MANUFACTURES STANDARDS

OF ABBREVIATIONS:

LIST OF	LIST OF ABBREVIATIONS:		
≵	ATTIC ACCESS	Ð	FLOOR DRAIN
ADJ.	ADJUSTABLE	FDN	FOUNDATION
AVB	AIR/VAPOUR BARRIER	긎	FLOOR
≵	ATTIC ACCESS	FURN	FURNACE
男	BROOM CLOSET	MECH.	MECHANICAL
B.U.	BUILT UP	0.C.	ON CENTER
CANT.	CANTILEVERED		PANTRY
ക	CENTER LINE	믹	PRESSURE TREATED
<u>و</u>	COLUMN	PWF	PRESERVED WOOD FOUNDATION
CONC.	CONCRETE	REINF.	REINFORCED
c/w	COMES WITH	ST.	STEEL
DW	DISHWASHER	0/1	TO OF
R	DOWN	∄.	TYPICAL
D	DRYER	U/S	UNDERSIDE OF
ELEC.	ELECTRICAL	VÁC	CENTRAL VACUUM
ENG.	ENGINEERED	W.I.C.	WALK IN CLOSET
."	FRIDGE	W	WASHING MACHINE
H.R.V.	HEAT RECOVERY VENTILATOR	W/H	WATER HEATER
CF F	INSULATED CONCRETE FORMS	ð,	WOOD
INSUL.	INSULATION	8	SMOKE DETECTOR
) (
		&	SMOKE/CARBON MONOXIDE DETECTOR
THESE ABBF	THESE ABBREVIATIONS MAY OR MAY NOT APPEAR ON THIS		

SAMPLE SET ONLY

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DRAWING NAME:

OF DRAWINGS

GENERAL NOTES

WINDOW SCHEDULE


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PROJECT #

2020-96

A-2.0

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SAMPLE DRAWINGS

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CODE AUTHORITY Of Saskatchewan

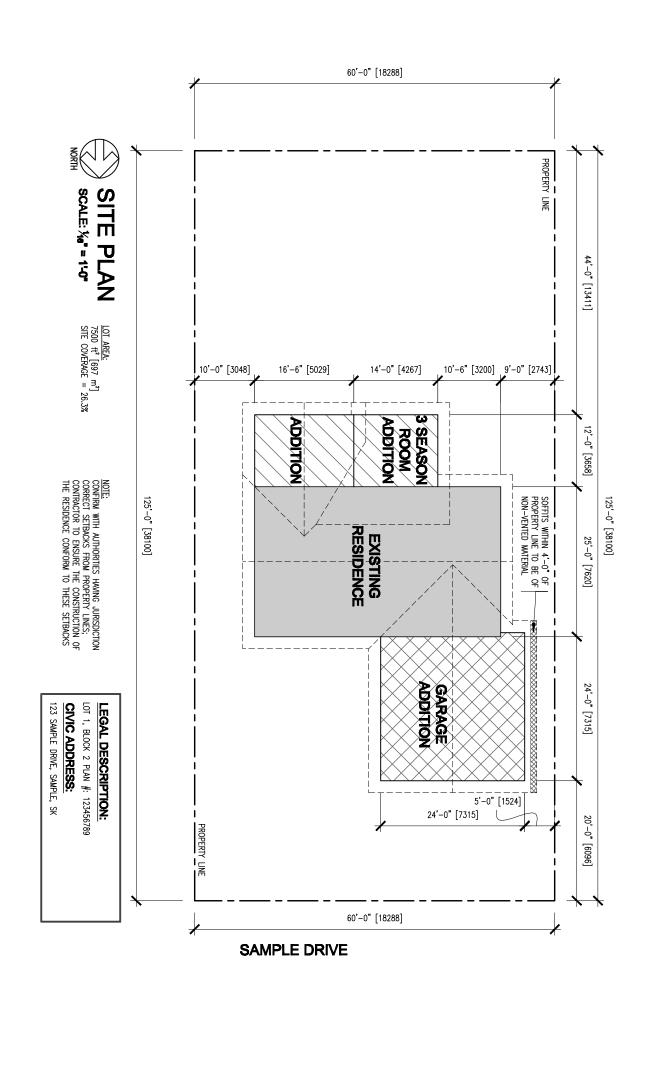CONSTRUCTION

SITE PLAN

DATE


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CODE

CONSTRUCTION

Of Saskatchewan AUTHORITY

BASEMENT FLOOR PLAN, EXISTING


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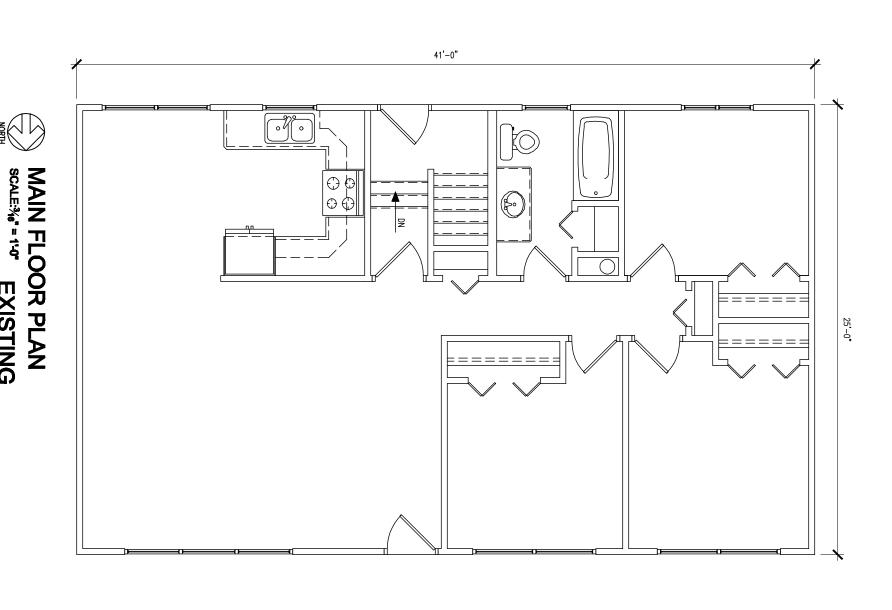
CONSTRUCTION
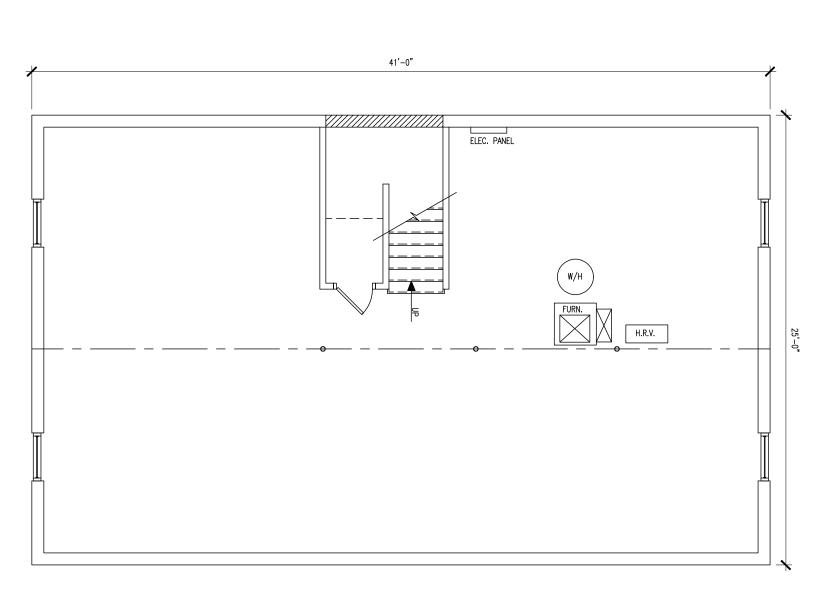
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Inc.

November 13, 2020

2020-96

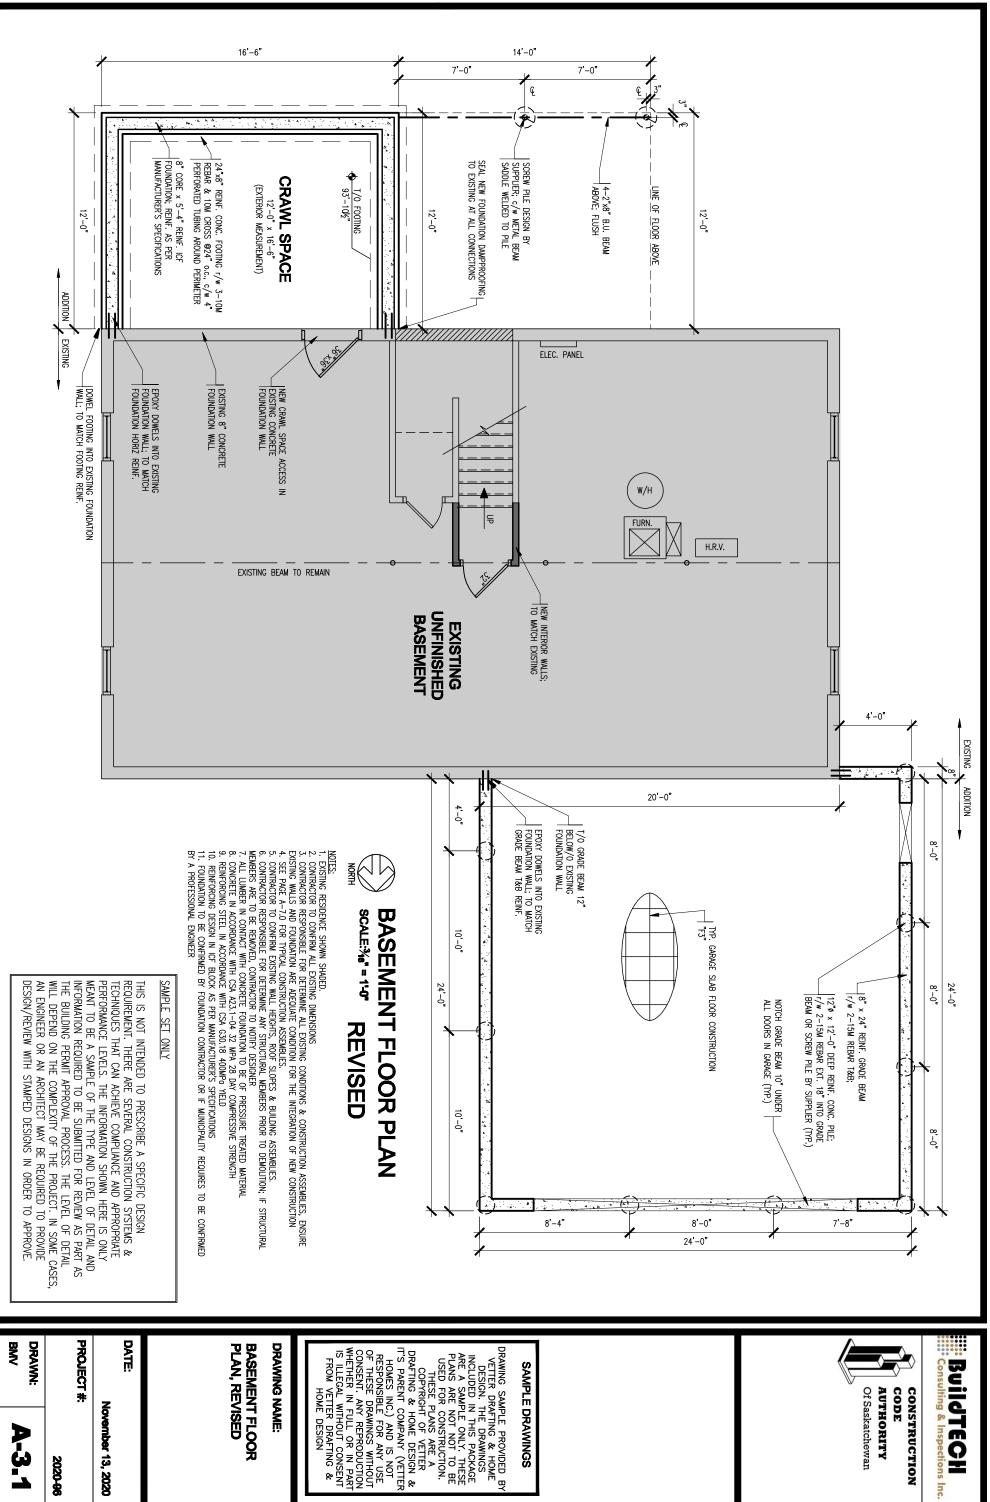

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EXISTING

MAIN FLOOR PLAN EXISTING

DRAWING NAME:

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SAMPLE DRAWINGS

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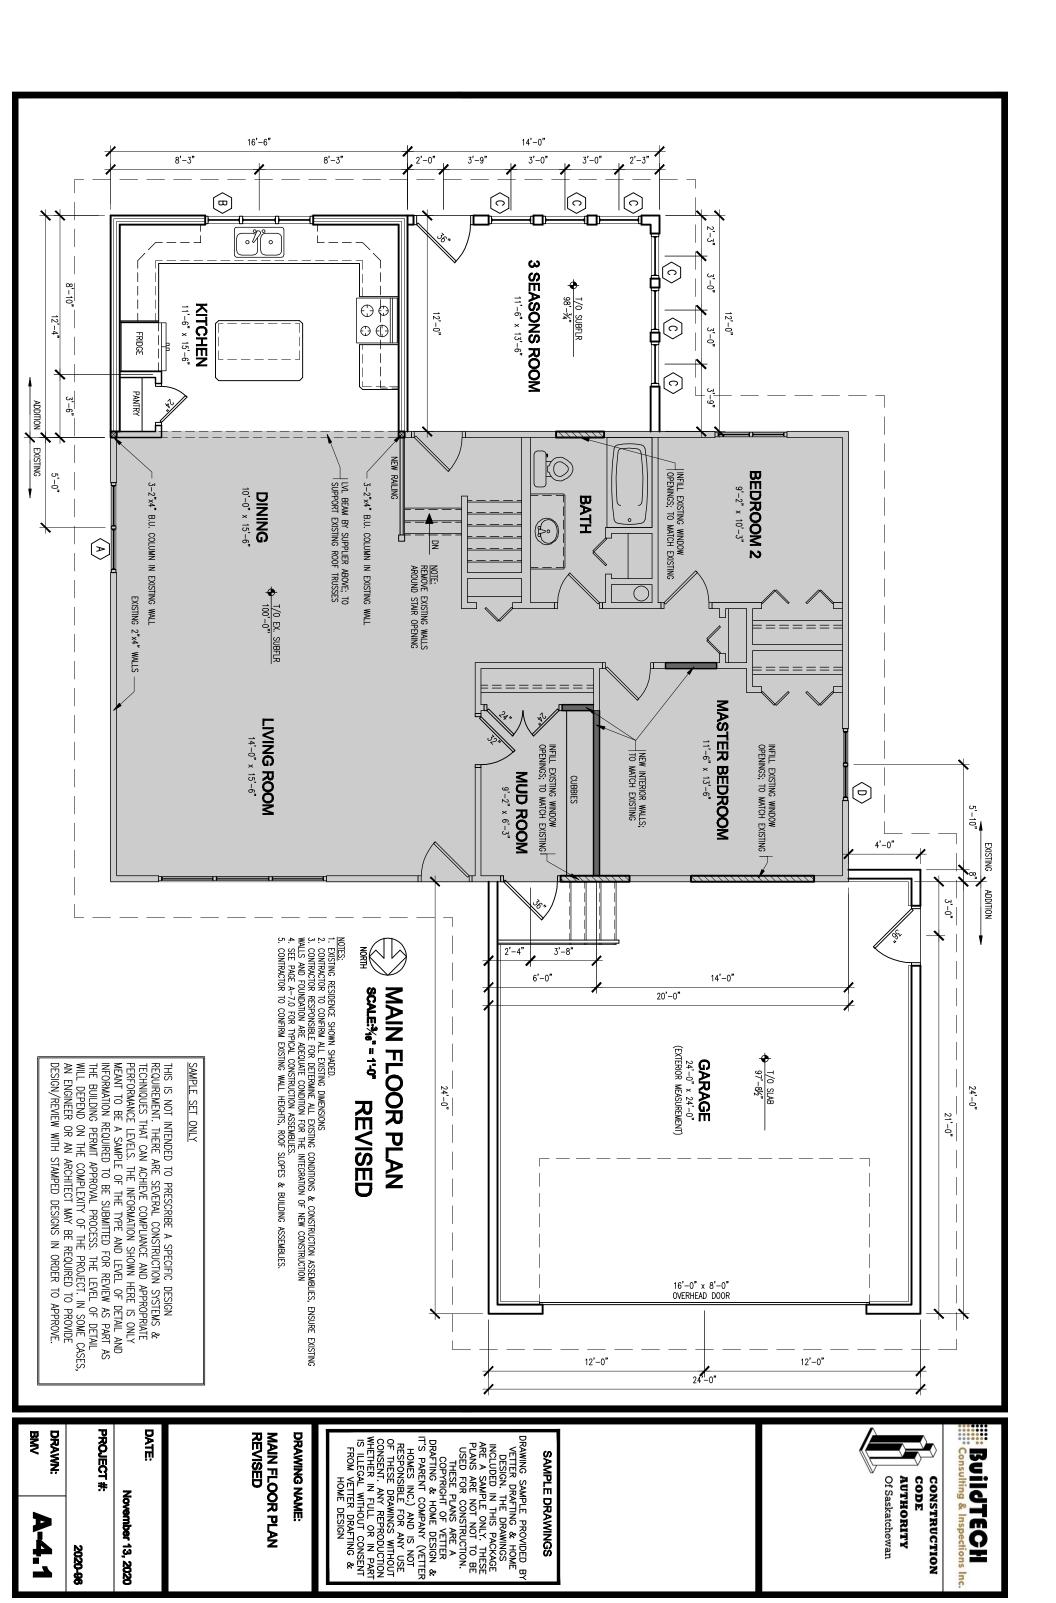
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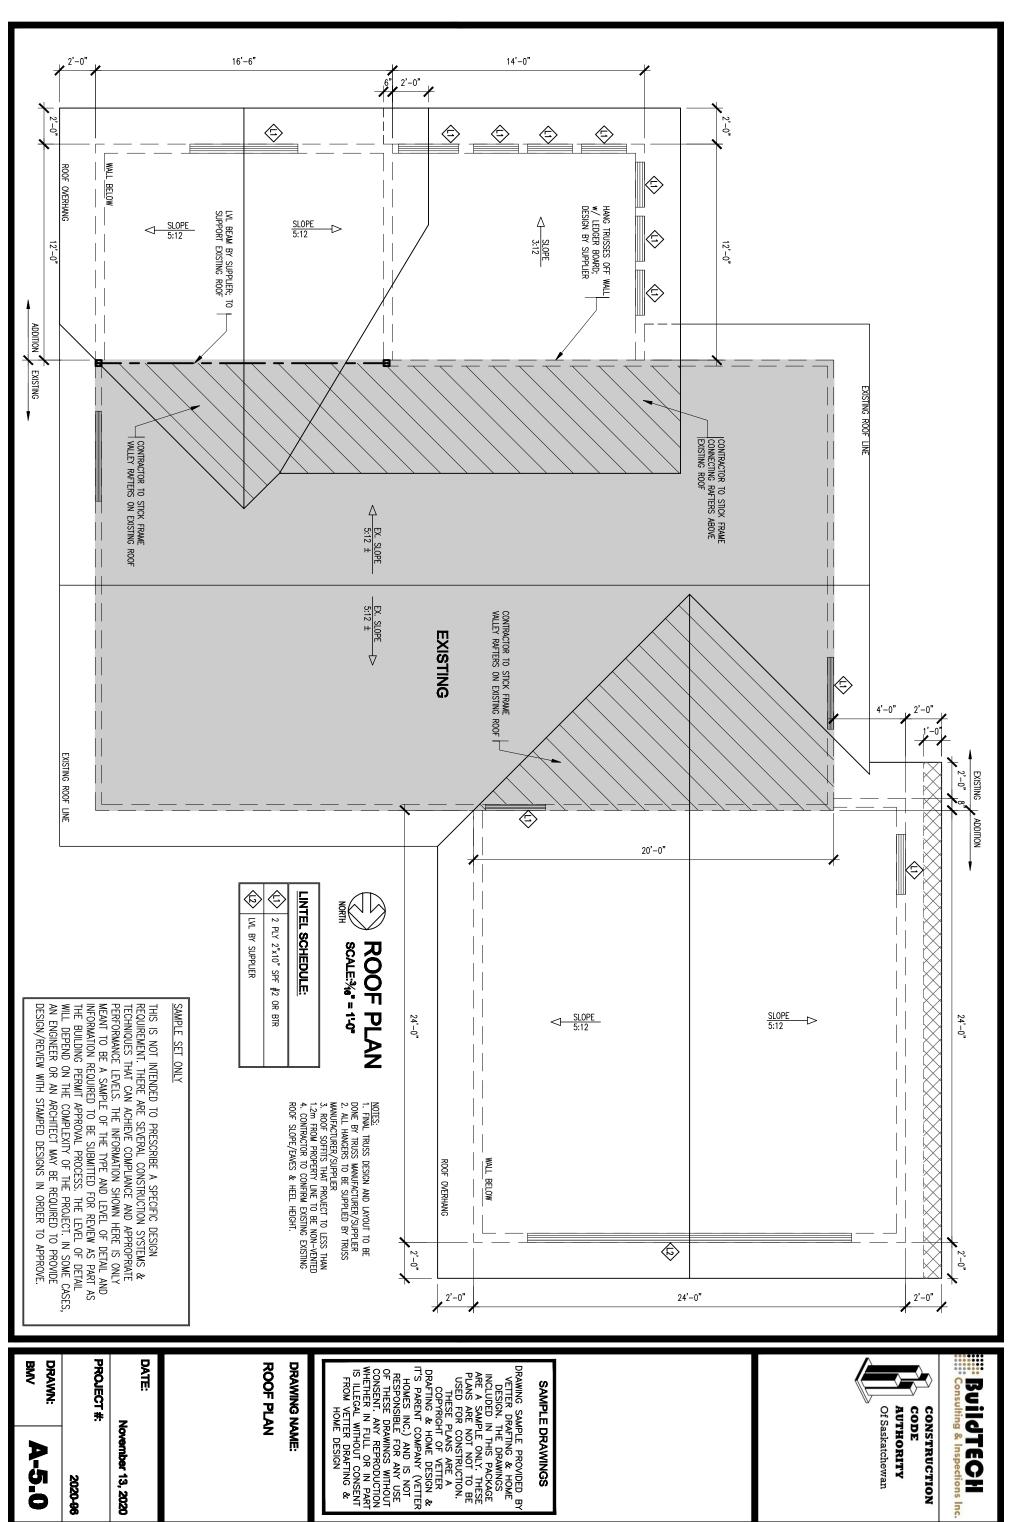
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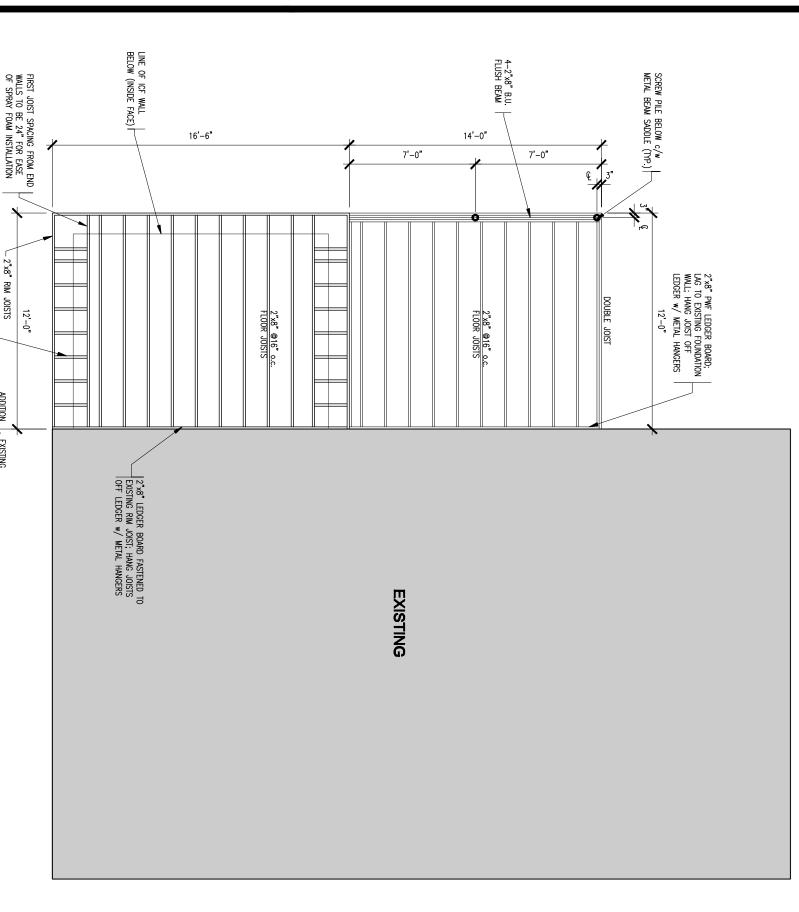




A-5.0

2020-86

BuildTECH ulting & Inspections Inc. CONSTRUCTION





SCALE:3/6" = 1'-0" MAIN FLOOR JOIST LAYOUT

- NOTES:

 1. CONTRACTOR TO CONFIRM ALL EXISTING DIMENSIONS

 2. CONTRACTOR RESPONSIBLE FOR DETERMINE ALL EXISTING CONDITIONS & CONSTRUCTION

 ASSEMBLIES, LESUSTING WALLS AND FOUNDATION ARE ADEQUATE CONDITION FOR THE

 INTEGRATION OF NEW CONSTRUCTION

 3. CONTRACTOR RESPONSIBLE FOR DETERMINE ANY STRUCTURAL MEMBERS PRIOR TO DEMOLITION;

 IF STRUCTURAL MEMBERS ARE TO BE REMOVED, CONTRACTOR TO NOTIFY DESIGNER

 4. ALL LUMBER IN CONTACT WITH CONCRETE FOUNDATION TO BE OF PRESSURE TREATED MATERIAL

SAMPLE SET ONLY

2"x8" @16" o.c. | END BLOCKING |

ADDITION

EXISTING

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SAMPLE DRAWINGS

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AUTHORITY Of Saskatchewan

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CONSTRUCTION

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DRAWING NAME:

MAIN FLOOR JOIST LAYOUT

DATE:

November 13, 2020

PROJECT #

2020-86

A-6.0

DRAWN:

TYPICAL CONSTRUCTION ASSEMBLIES:

SEE PAGE A-7.1 & A-7.2 FOR CALCULATIONS FOR ENERGY EFFICIENCY OF BUILDING ASSEMBLIES TO MEET SECTION 9.36.2. "PRESCRIPTIVE PATH" OF THE "2015 NATIONAL BUILDING CODE OF CANADA". RESIDENCE MAY BE ENERGY MODELED "PERFORMANCE PATH" BY OTHERS TO MEET SECTION 9.36.5. OF THE "2015 NATIONAL BUILDING CODE OF CANADA"

TYP. ROOF CONSTRUCTION ABOVE KITCHEN ASPHALT SHINGLES

- ROOF VENTING AS REQUIRED
 EAVE PROTECTION AS REQUIRED
 %6" OSB SHEATHING c/w H-CLIPS
 ENG. TRUSSES @24" o.c.
- TO MATCH EXISTING HEEL CONTRACTOR TO CONFIRM R60 BLOWN-IN INSULATION
- 1 1
- 6mil POLY AIR/VAPOUR BARRIER c/w ACOUSTIC COMPOUND & BLUE TUCK TAPE
- ½" CEILING DRYWALL (TAPED & SANDED)

 FINISH AS PER OWNER

 NOTE: 1ft² ROOF VENTS PER 300ft² ATTIC SPACE

 INSULATION MUST REACH FULL R/RSI-VALUE

 AT 1.2m FROM EXTERIOR WALL

 7.7 FROM EXTERIOR WALL
- R20 MIN. ABOVE EXTERIOR WALL @ EAVES

TYP. ROOF CONSTRUCTION ABOVE GARAGE ASPHALT SHINGLES

- ROOF VENTING AS REQUIRED
 EAVE PROTECTION AS REQUIRED
 "Y6" OSB SHEATHING c/w H-CLIPS
 ENG. TRUSSES @24" o.c.
- TO MATCH EXISTING HEEL CONTRACTOR TO CONFIRM
- R40 BATT INSULATION
 6mil POLY AIR/VAPOUR BARRIER
- c/w ACOUSTIC COMPOUND & BLUE TUCK TAPE
- ½" CEILING DRYWALL (TAPED & SANDED)
 FINISH AS PER OWNER
 NOTE: 1ft² ROOF VENTS PER 300ft² ATTIC SPACE
- GARAGE ROOF NEED NOT COMPLY WITH 9.36. OF NBC 2015 AS PER A-9.36.1.3.(5)

TYP. ROOF CONSTRUCTION ABOVE 3 SEASONS ROOM ASPHALT SHINGLES

- ROOF VENTING AS REQUIRED
- ROOF VENTING AS REQUIRED
 EAVE PROTECTION AS REQUIRED
 7/6" OSB SHEATHING c/w H-CLIPS
 ENG. TRUSSES @24" o.c.
 STANDAR HEEL HEIGHT
 R40 BATT INSULATION
- 6mil POLY AIR/VAPOUR BARRIER
- c/w ACOUSTIC COMPOUND & BLUE TUCK TAPE CEILING DRYWALL (TAPED & SANDED)

- FNISH AS PER OWNER

 NOTE: 1ft² ROOF VENTS PER 300ft² ATTIC SPACE

 3 SEASON'S ROOM ROOF NEED NOT COMPLY WITH

 9.36. OF NBC 2015 AS PER A-9.36.1.3.(5) AS IT IS UNHEATED

- TYP. EAVE CONSTRUCTION

 PREFINISHED 5" CONTINUOUS METAL EAVESTROUGH
- PREFINISHED METAL FASCIA
- 2"x6" SPF FASCIA BOARD PREFINISHED METAL VENTED SOFFITS INSULATION BAFFLES
- OSB MUST BE APPLIED UNDER SOFFITS; OR A NON VENTED SOFFIT MAY BE USED SOFFITS ARE WITHIN 1.2m OF PROPERTY LINE 1/2" EXTERIOR GRADE DRYWALL OR

\bigcirc TYP. EXTERIOR WALL CONSTRUCTION

- BUILDING WRAP
 METAL FLASHINGS OVER ALL EXTERIOR OPENINGS
 ¾" O.S.B. SHEATHING
 2"x6" WD. STUDS @ 16" o.c.
- R24 BATT INSULATION
- 6mil POLY AIR/VAPOUR BARRIER
 c/w ACOUSTIC COMPOUND & BLUE TUCK TAPE
- ½" DRYWALL (TAPED & SANDED)FINISH AS PER OWNER

- TYP. FOUNDATION WALL CONSTRUCTION

 PARGING ABOVE GRADE

 DAMPPROOFING BELOW GRADE

 8" CORE ICF. FROST WALL

 REINF. AS PER MANUFACTURER'S SPECIFICATIONS
- り DRYWALL

TYP. INTERIOR WALL CONSTRUCTION

- FINISH AS PER OWNER

- 4"Ø PERFORATED TUBING
- 6" CRUSHED ROCK MIN. ABOVE PERFORATED TUBING

- 12" ϕ \times 12'-0" DEEP REINF. CONC. PILE r/w 2-15M REBAR EXT 18" INTO GRADE BEAM

TYP. GARAGE/3 SEASONS ROOM WALL CONSTRUCTION

- BUILDING WRAP VINYL SIDING
- METAL FLASHINGS OVER ALL EXTERIOR OPENINGS %" O.S.B. SHEATHING 2"x6" WD. STUDS @ 16" o.c. c/w PWF BOTTOM PLATE

- ½" DRYWALL (TAPED & SANDED)
 FINISH AS PER OWNER
 NOTE: GARAGE/3 SEASONS ROOM WALLS NEED NOT COMPLY WITH R20 BATT INSULATION
 6mil POLY AIR/VAPOUR BARRIER
 c/w ACOUSTIC COMPOUND & BLUE TUCK TAPE
- 9.36. OF NBC 2015 AS PER A-9.36.1.3.(5)

- W4 HOUSE/GARAGE DIVIDING WALL CONSTRUCTION
 5%" TYPE "X" DRYWALL (TAPED & SANDED)
 EXISTING WALL CONSTRUCTION TO REMAIN

(§ - FINISH AS PER OWNER

- ½" DRYWALL (TAPED & SANDED) 2"x4" WD. STUDS @ 16" o.c. (2"x6" AS NOTED)
- ½" DRYWALL (TAPED & SANDED)

P. FOOTING CONSTRUCTION 24"x8" REINF. CONC. FOOTING

- ON UNDISTURBED SOIL
- r/w 3-10M REBAR CONTINUOUS & 10M CROSS @24" o.c. DOWEL NEW FOOTING INTO EXISTING FOUNDATION; TO MATCH REINF.

- 4"x24" RIGID INSULATION FROST PROTECTION AROUND PERIMETER

TYP. GARAGE GRADE BEAM CONSTRUCTION - 8"x24" REINF. CONC. GRADE BEAM r/w 2-15M TOP & BOTTOM c/w 6" VOID FORM BETWEEN PILES

SAMPLE SET ONLY

 \bigcirc TYP. MAIN FLOOR CONSTRUCTION

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- FINISHED FLOORING AS PER OWNER
 ¾" T&G PLYWOOD SUBFLOOR; SCREWED & GLUED TO MATCH EXISTING
 2"x8" @16" o.c FLOOR JOISTS
- NOTE: RIM JOIST TO BE SPRAY FOAMED WITH MIN. R22 INSULATION

Of Saskatchewan AUTHORITY CODE CONSTRUCTION

(F) SPACE FLOOR CONSTRUC NOI

- 3" CONCRETE SLAB- 6mil POLY DAMPPROOFING;
- SEALED TO FDN WALL AND ALL PENETRATIONS $\mbox{\ensuremath{\mathsf{w}/}}$ ACOUSTIC COMPOUND & BLUE TUCK TAPE SEALED TO FDN WALL AND ALL
- 8" COMPACTED CRUSHED ROCK (4" MN.)
- NOTE: ROUGH IN PIPE FOR RADON GAS AS
 PER NBC 2015 (9.13.4.3)
 SLAB NEED NOT BE INSULATED AS
 FOUNDATION IS INSULATED ON EXTERIOR AS PER 9.36.2.8 4)a)

TYP. GARAGE SLAB CONSTRUCTION - 4" CONCRETE SLAB

- r/w 10M @24" o.c. EACH WAY;
- DOWELED INTO GRADE BEAM/EXISTING FOUNDATION WALL
- SLOPE CONCRETE TO CENTER FLOOR DRAIN 6mil POLY DAMPPROOFING;
 SEALED TO GRADE BEAM AND ALL PENETF PENETRATIONS
- W/ ACOUSTIC COMPOUND & BLUE TUCK TAPE

 MIN. 8" COMPACTED BASE FILL

 NOTE: GARAGE SLAB NEED NOT COMPLY WITH

 9.36. OF NBC 2015 AS PER A-9.36.1.3.(5)
- SEASONS ROOM FLOOR CONSTRUCTION FINISHED FLOORING AS PER OWNER 34" T&G PLYWOOD SUBFLOOR; SCREWED 6mil POLY AIR/VAPOUR BARRIER
- c/w ACOUSTIC COMPOUND & BLUE TUCK TAPE 2"x8" @16" o.c FLOOR JOISTS R28 BATT INSULATION
- %" PWF PLYWOOD

SAMPLE DRAWINGS

DESIGN. THE DRAWINGS

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DRAWING NAME:

CONSTRUCTION TYPICAL ASSEMBLIES

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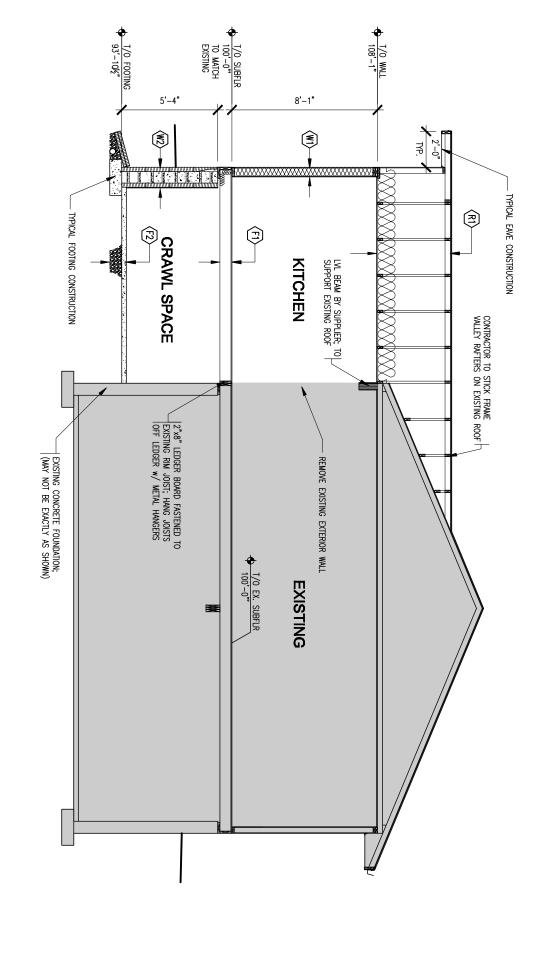
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PROJECT

2020-86



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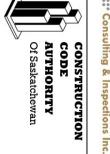


BUILDING SECTION

- NOTES:
 1. CONTRACTOR TO CONFIRM ALL EXISTING DIMENSIONS
 2. CONTRACTOR RESPONSIBLE FOR DETERMINE ALL EXISTING CONDITIONS & CONSTRUCTION ASSEMBLIES, ENSURE EXISTING WALLS AND FOUNDATION ARE ADEQUATE CONDITION FOR THE INTEGRATION OF NEW CONSTRUCTION
 3. CONTRACTOR RESPONSIBLE FOR DETERMINE ANY STRUCTURAL MEMBERS PRIOR TO DEMOLITION; IF STRUCTURAL MEMBERS ARE TO BE REMOVED, CONTRACTOR TO NOTIFY DESIGNER
 4. CONTRACTOR TO CONFIRM ALL EXISTING ROOF SLOPES/EAVES/HEEL HEIGHTS.
 5. ALL LUMBER IN CONFACT WITH CONCRETE FOUNDATION TO BE OF PRESSURE TREATED MATERIAL
 6. TOP OF FOUNDATION TO BE 8" ABOVE GRADE (MIN.)
 7. ROUGH IN PIPE FOR RADON GAS AS PER NBC 2015 (9.13.4.3)
 8. SEE PAGE A-7.0 FOR TYPICAL CONSTRUCTION ASSEMBLIES
 9. REINFORCING DESIGN IN ICF BLOCK AS PER MANUFACTURER'S SPECIFICATIONS

SAMPLE SET ONLY

THIS IS NOT INTENDED TO PRESCRIBE A SPECIFIC DESIGN REQUIREMENT. THERE ARE SEVERAL CONSTRUCTION SYSTEMS & TECHNIQUES THAT CAN ACHIEVE COMPLIANCE AND APPROPRIATE PERFORMANCE LEVELS. THE INFORMATION SHOWN HERE IS ONLY MEANT TO BE A SAMPLE OF THE TYPE AND LEVEL OF DETAIL AND INFORMATION REQUIRED TO BE SUBMITTED FOR REVIEW AS PART AS THE BUILDING PERMIT APPROVAL PROCESS. THE LEVEL OF DETAIL WILL DEPEND ON THE COMPLEXITY OF THE PROJECT. IN SOME CASES, AN ENGINEER OR AN ARCHITECT MAY BE REQUIRED TO PROVIDE DESIGN/REVIEW WITH STAMPED DESIGNS IN ORDER TO APPROVE.



BuildTECH



DRAWING NAME:

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SAMPLE DRAWINGS

BUILDING SECTION

DATE


November 13, 2020

PROJECT #:

2020-96

A-8.0

DRAWN:

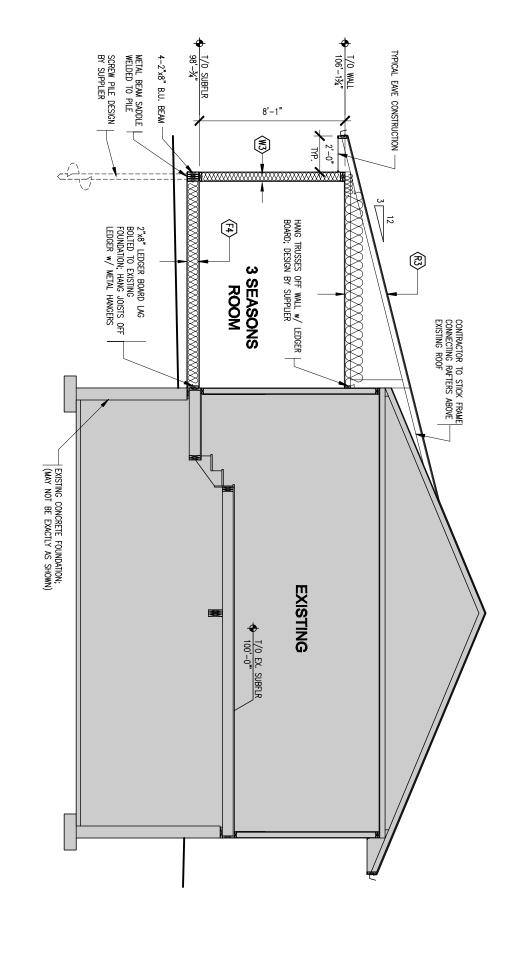

BUILDING SECTION

SCALE: 3/6" = 1'-0"

- NOTES:

 1. CONTRACTOR TO CONFIRM ALL EXISTING DIMENSIONS
 2. CONTRACTOR RESPONSIBLE FOR DETERMINE ALL EXISTING CONDITIONS & CONSTRUCTION ASSEMBLIES, ENSURE EXISTING WALLS AND FOUNDATION ARE ADEQUATE CONDITION FOR THE INTEGRATION OF NEW CONSTRUCTION
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DRAWING NAME:

BUILDING SECTION


DATE

PROJECT #

November 13, 2020

2020-96

DRAWN:

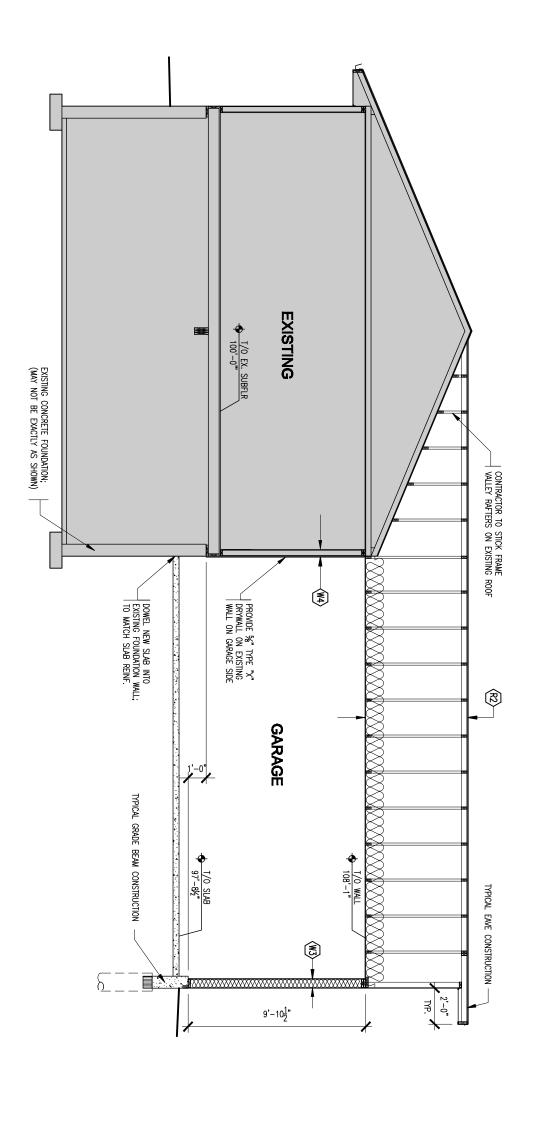

BUILDING SECTION

SCALE:3/6" = 1'-0"

- NOTES:

 1. CONTRACTOR TO CONFIRM ALL EXISTING DIMENSIONS

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SAMPLE DRAWINGS

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sulting & Inspections Inc.

CONSTRUCTION

Of Saskatchewan AUTHORITY CODE

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BUILDING SECTION


DATE

November 13, 2020

PROJECT #

2020-96

DRAWN:

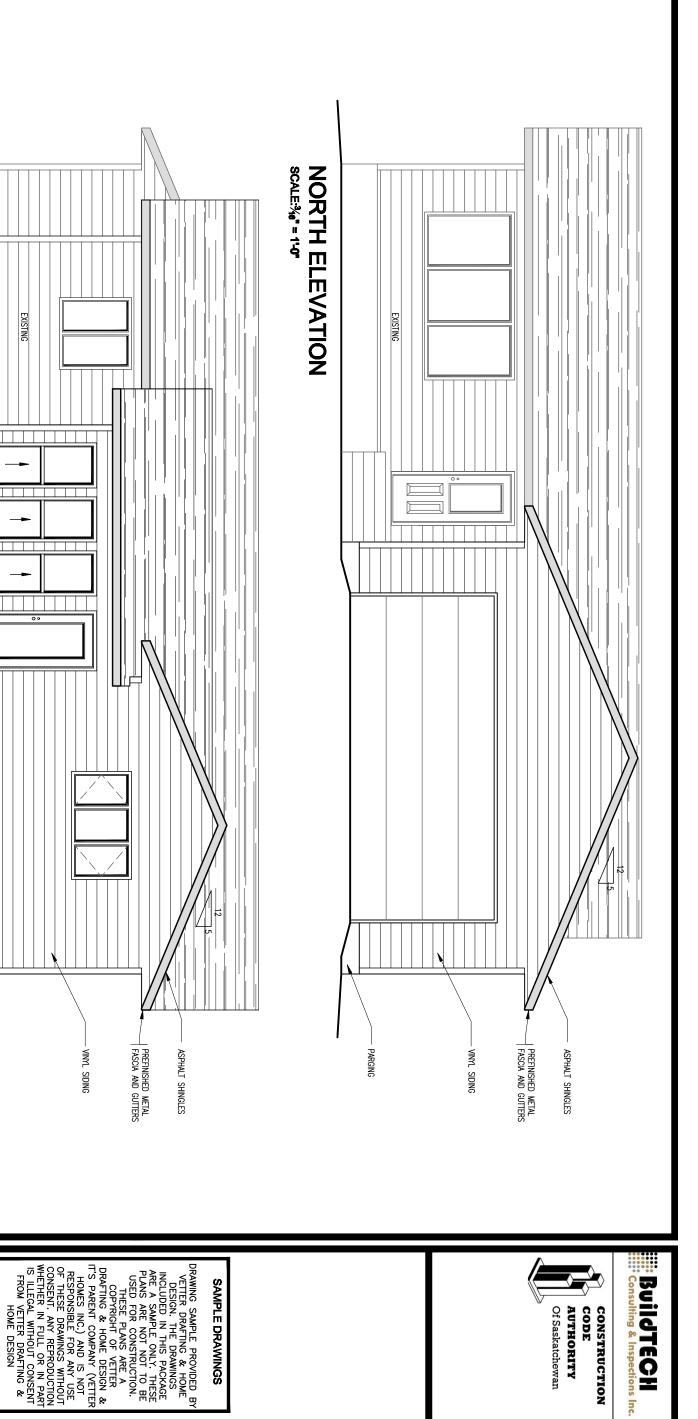

AUTHORITYOf Saskatchewan

CODE

CONSTRUCTION

ections Inc.

SOUTH ELEVATION SCALE 3/4" = 1'-0"

EXISTING

SAMPLE SET ONLY

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DRAWING NAME:

SAMPLE DRAWINGS

PARGING

EXTERIOR ELEVATIONS

DATE:


November 13, 2020

PROJECT #:

2020-96

DRAWN:

A-9.0

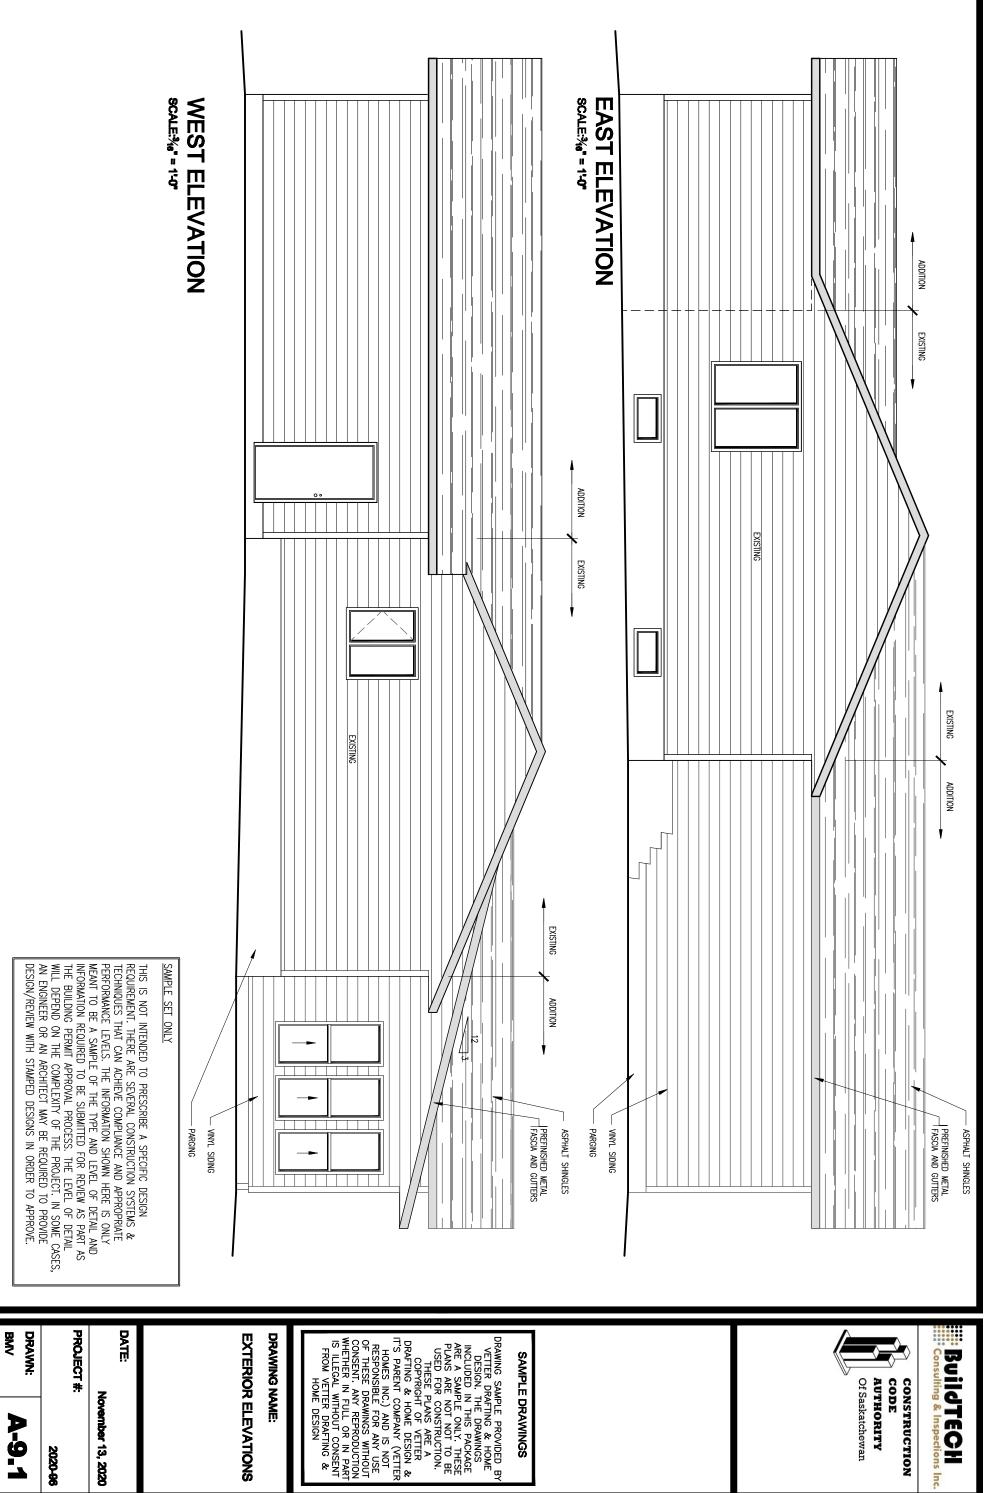

BuildTECH Consulting & Inspections Inc.

CODE

CONSTRUCTION

Of Saskatchewan AUTHORITY

EXTERIOR ELEVATIONS

November 13, 2020

2020-96

A-9.1